HTR DREAM AWAY - ILLUSTRATIVE MASTER PLAN

Back of house "barn" w/ offices & storage -

Maintenance "barn" & yard w/ tractor, cart storage Guest parking Guest cabin and outdoor patio (typ.)

Guest amenity space with orchard and lawn

Main gravel path; no guest vehicles permitted

Guest pool, hot tub, and outdoor lounge area "Lodge" w/ check-in and indoor guest amenities Check-in, golf cart, and bike parking

Existing pond

1 1 1 1 1 K

100

Camp games and lawn activities

Utility "barn" w/ trash service HTR Dream Away entry sign

Guest amenity space with area for gathering, small music performances and outdoor art displays

Existing Dream Away Lodge and grounds; no proposed changes

Stabilized crusher fines trail system throughout; 4' -5' width varies





Canvas wall tents (typ.) "Artist in residence" tent Guest lounge tent w/ books and boardgames Free-standing spa(s) (typ.)

Free-standing sauna(s) of various sizes (typ.)

Stargazing glade

Stabilized crusher fines paths to tent(s); ~4' width (typ.)

Guest amenity lawn space

"Dream Away Village" units; a collection of eclectic, vintage units and funky character that reflects flavor of the adjacent Dream Away Lodge

Guest amenity space w/ small contemplative gathering areas, fire pits, and swing chairs surrounded by native woods

Area of no activity near abutter

Emergency vehicle and staff access only; gravel path 16' width (2' shoulders)



CLEARING SCHEDULE



ACRES

GENERAL CLEARING NOTES:

• IT IS THE DESIGN INTENT FOR THIS PROJECT TO DISTURB AS LITTLE OF THE SITE AS POSSIBLE.

CLEARING AND GRUBBING 19.12

- IN ALL CASES, PERFORM WORK SO AS TO MINIMIZE TREE CLEARING AND DISTURBANCE AREAS.
- ADDITIONAL CLEARING NOT SPECIFICALLY REQUIRED FOR CONSTRUCTION OF SITE AMENITIES MAY BE PERMITTED AS NECESSARY FOR FIRE SAFETY OR FOREST HEALTH.
- WORK WITH OR AROUND EXPOSED LEDGE FORMATIONS WHENEVER POSSIBLE, TAKING CARE DURING CONSTRUCTION TO AVOID OR MINIMIZE DAMAGE TO EXPOSED ROCK FACES, LICHEN GROWTH, ETC.

CLEARING NOTES FOR TENTS:


- FIELD LOCATE TENTS SO AS TO MINIMIZE DISTURBANCE TO TREES OVER 12" IN DIAMETER.
- REMOVE TREES WITHIN 3' OF TENT PLATFORM. TRIM ANY OVERHANGING BRANCHES THAT TOUCH OR MAY TOUCH CANVAS AFTER ERECTION OF TENT.
- REMOVE UNDERGROWTH WITHIN 6' OF TENT PLATFORM.

CLEARING NOTES FOR FOOT PATHS:

- FIELD LOCATE FOOT PATHS SO AS TO MINIMIZE DISTURBANCE TO TREES OVER 12" IN DIAMETER.
- TRIM UNDERGROWTH AND OVERHANGING BRANCHES ADJACENT TO THE PATHS TO ALLOW FOR A MIN 5' WIDE BY 9' HIGH CLEAR PASSAGE, OR GREATER IF INDICATED ON PLANS.

CLEARING NOTES FOR CABIN CLUSTERS:

 REMOVE TREES AND UNDERGROWTH ONLY AS NECESSARY FOR PLACEMENT OF CABINS UNITS.

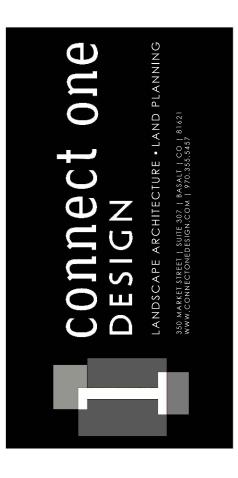

\succ MA ROAD 4 01223 Σ COUNTY 4 MA Ш BECKET, 342 -HTR


Drawn By: CPS, JE C	hecked	l By: ST
ISSUE & REVIS	ION D	ATES
SITE PLAN APPLICATION	N	02/01/2022
Plot Date [:] 01/28/22	Proie	ct # 459 2


PRELIMINARY

CLEARING

L.0.01

PLAN

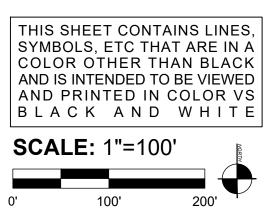


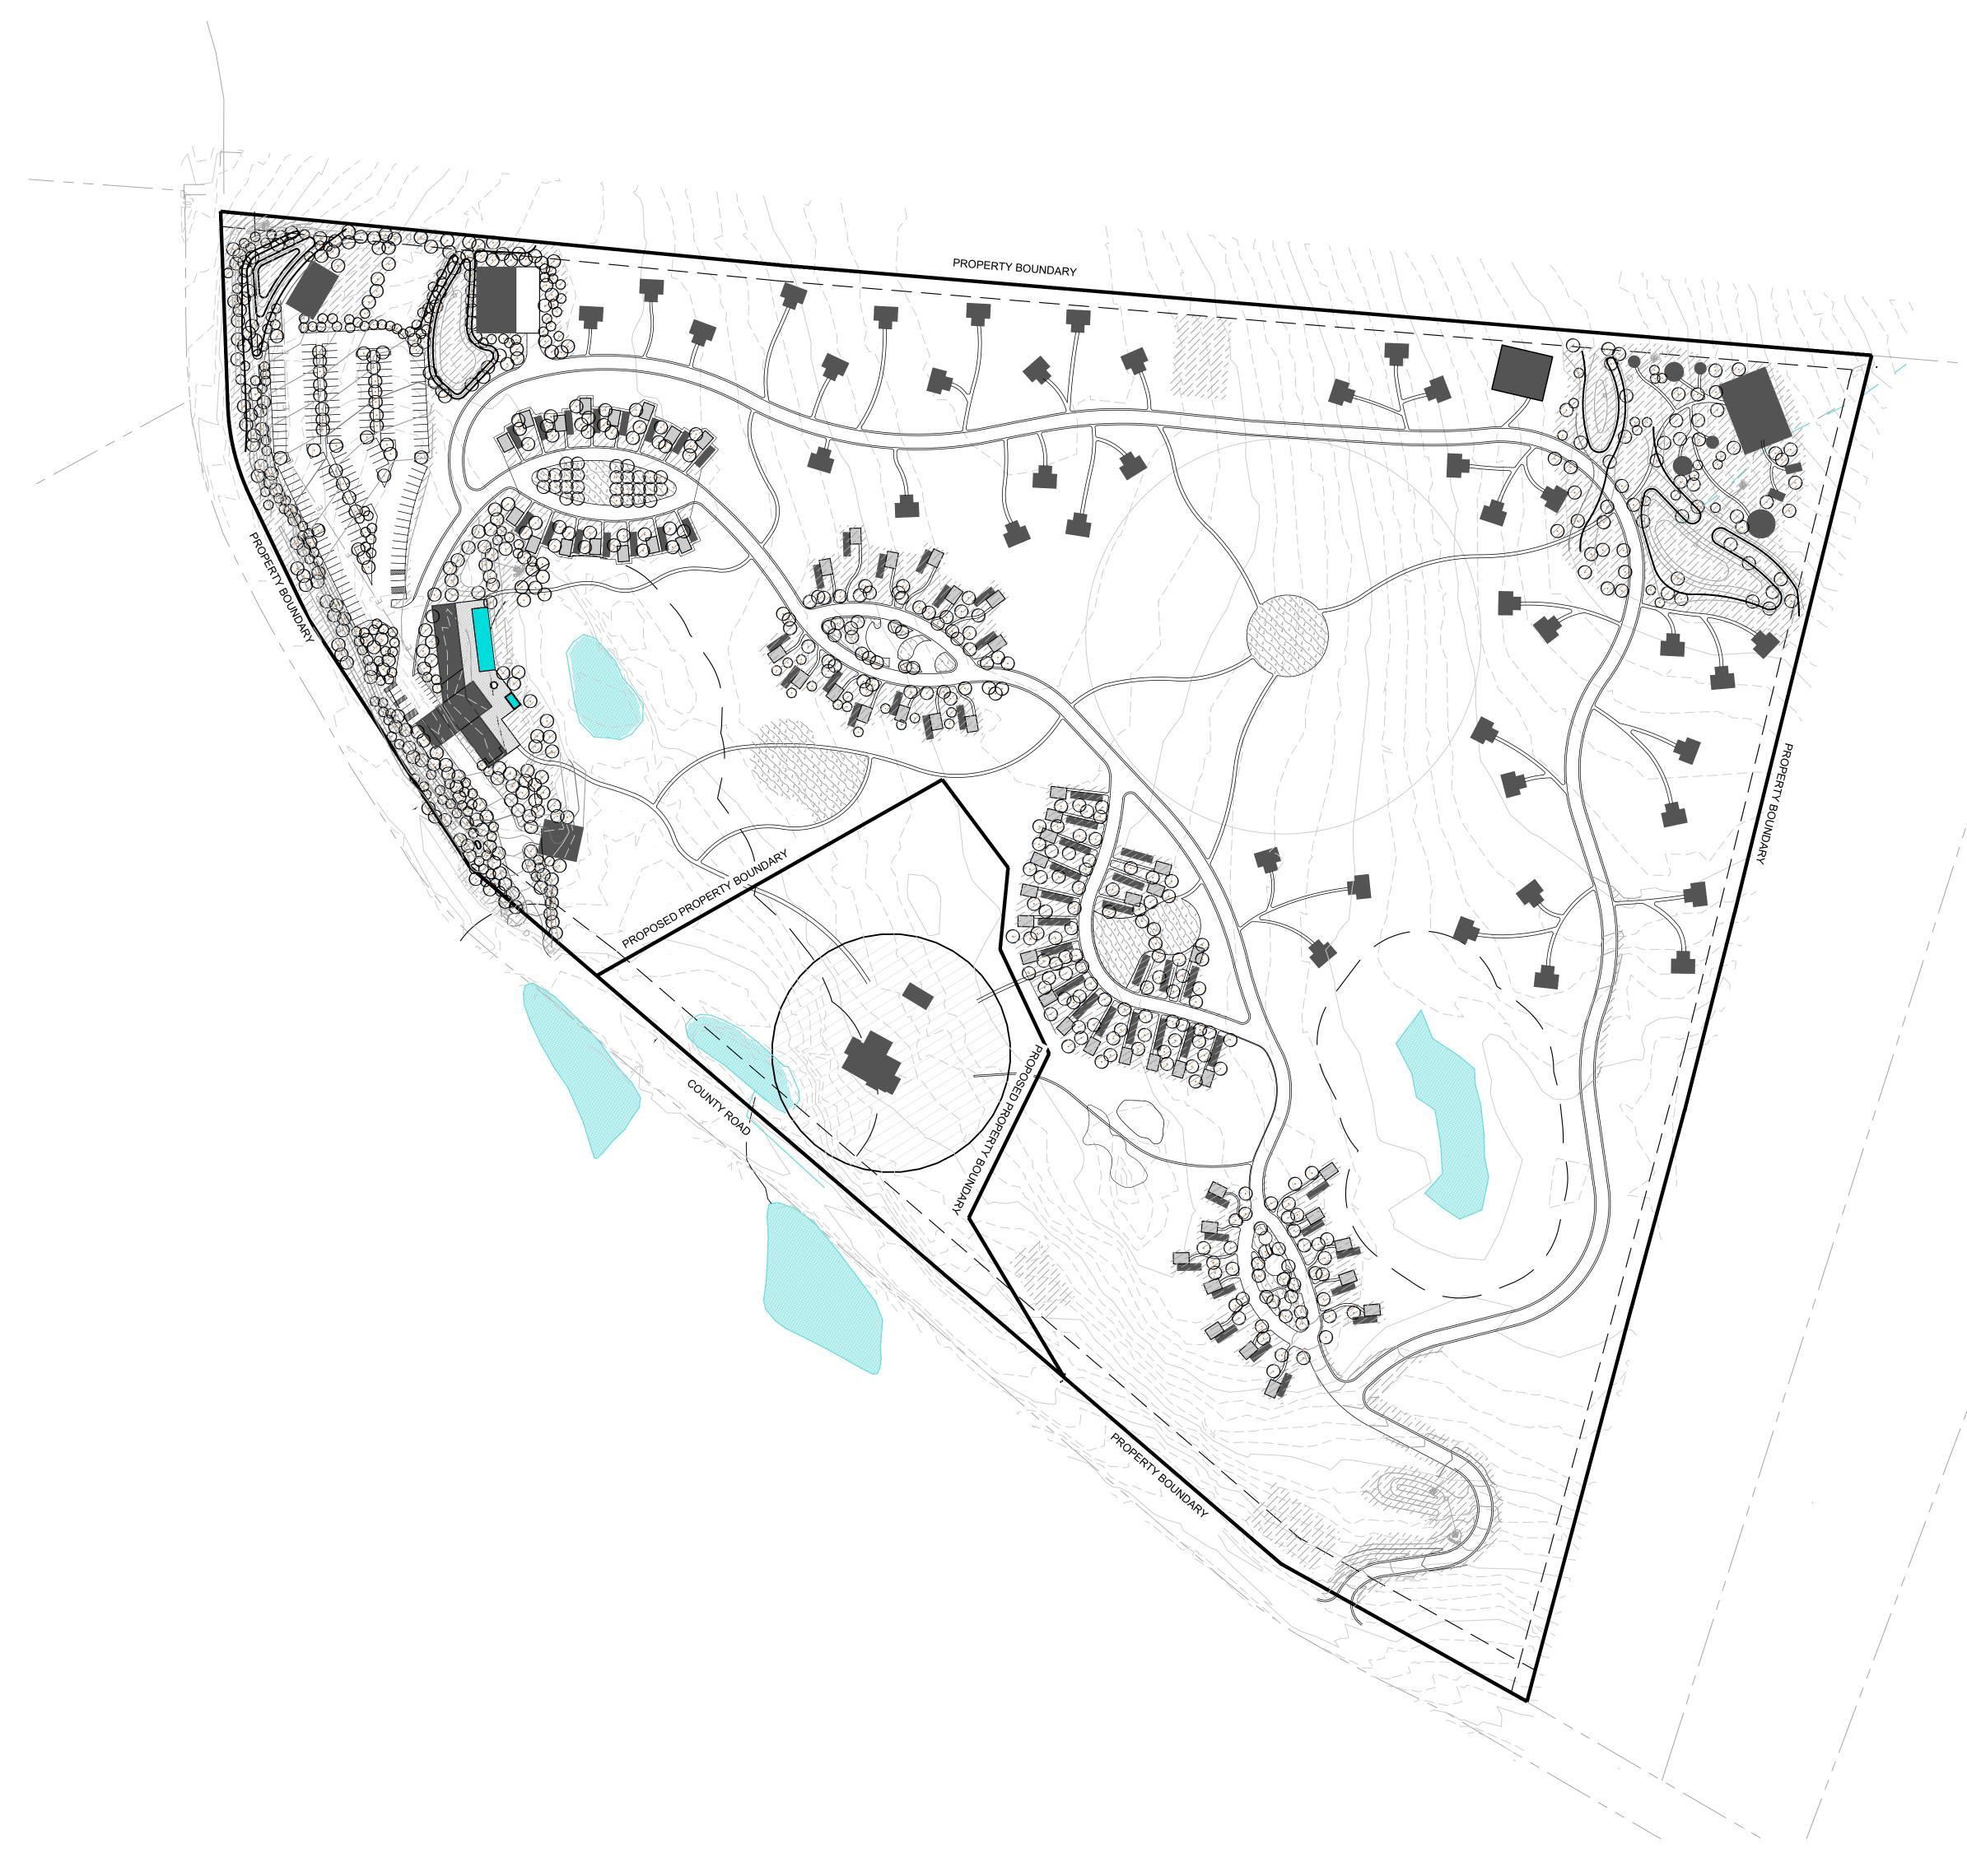

CONCEPT	FPLANT SCHEDULE	
yy www.cute a for the	EVERGREEN TREE -	188
·	DECIDUOUS TREE -	582
	NATIVE REVEGETATION AREA	401,953 SF
	ORNAMENTAL PLANTINGS OR LAWN -	43,952 SF

GENERAL PLANTING NOTES:


- ALL SPECIES, INCLUDING TREES, TO BE PLANTED IN REVEGETAION AREAS SHALL MATCH SPECIES ENDEMIC TO THIS SITE, OR OTHERWISE BE NATIVE TO THE OCTOBER MOUNTAIN STATE FOREST AREA.
- NO NOXIOUS OR NUISANCE SPECIES SHALL BE USED ON THE SITE, OR SPECIES THAT POSE A RISK OF ESCAPE INTO THE WETLANDS OR SURROUNDING AREA.

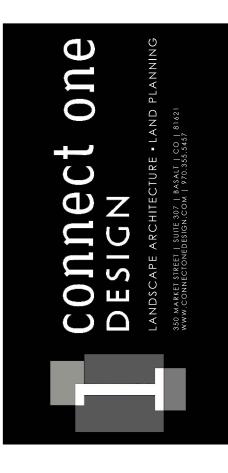

AMAWAY ROAD 01223 COUNTY **BECKET, MA** DRE, 1342 HTR

Drawn By: CPS, JE Checked By: ST					
ISSUE & REVISION DATES					
SITE PLAN APPLICATION 02/01/202					
Plot Date: <u>01/28/22</u>	Proje	ect #: <u>459.2</u>			

THIS SHEET CONTAINS LINES, SYMBOLS, ETC THAT ARE IN A COLOR OTHER THAN BLACK AND IS INTENDED TO BE VIEWED AND PRINTED IN COLOR VS B L A C K A N D W H I T E

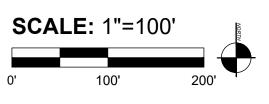

PRELIMINARY PLANTING PLAN

L.0.02





<u>SYMBO</u>



LIGHTING SCHEDULE

SYMBOL	DESCRIPTION	QTY	DETAIL
\bigcirc	BEGA 77 237 PATH LIGHT	1,337	
	BEGA ON-GROUND SURFACE WASH	351	
\bigcirc	BEGA POLE-TOP LUMINAIRE 99 402; 12` MOUNT HEIGHT	24	
	BEGA POLE-TOP TWIN LUMINAIRE 99 462; 12` MOUNT HEIGHT	13	
	BEGA WALL LUMINAIRE 44 418	33	


GENERAL SITE LIGHTING NOTES

ALL LIGHTING SHALL BE INSTALLED BY A LICENSED ELECTRICAN(S) IN CONFORMANCE WITH ALL APPLICABLE REGULATORY CODES. THE CONTRACTOR AND/OR ELECTRICIAN SHALL OBTAIN ALL REQUIRED PERMITS PRIOR TO INSTALLATION.

THE CONTRACTOR AND/OR ELECTRICIAN SHALL PROVIDE SUBMITTALS OF ALL
FIXTURES FOR APPROVAL PRIOR TO INSTALLATION.


• THE CONTRACTOR SHALL FIELD STAKE THE LOCATION OF ALL SPECIFIED FREESTANDING LIGHTING UNITS SHOWN ON THE PLAN.

THE CONTRACTOR SHALL INSTALL ALL LIGHT FIXTURES PER THE MANUFACTURER'S RECOMMENDATIONS.

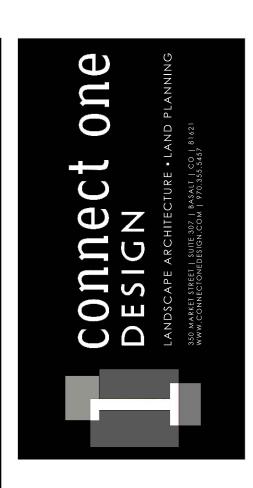

AMAWAY ROAD 01223 COUNTY BECKET, MA DRE 1342 HTR

Drawn By: CPS, JE Che	cked By: ST				
ISSUE & REVISION DATES					
SITE PLAN APPLICATION 02/01/2022					
Plot Date: <u>01/28/22</u> F	Project #: <u>459.2</u>				

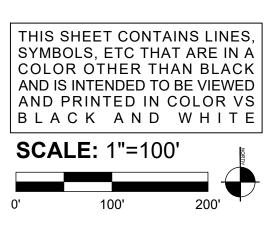

PRELIMINARY LANDSCAPE LIGHTING DIAGRAM

LIGHT.1.1


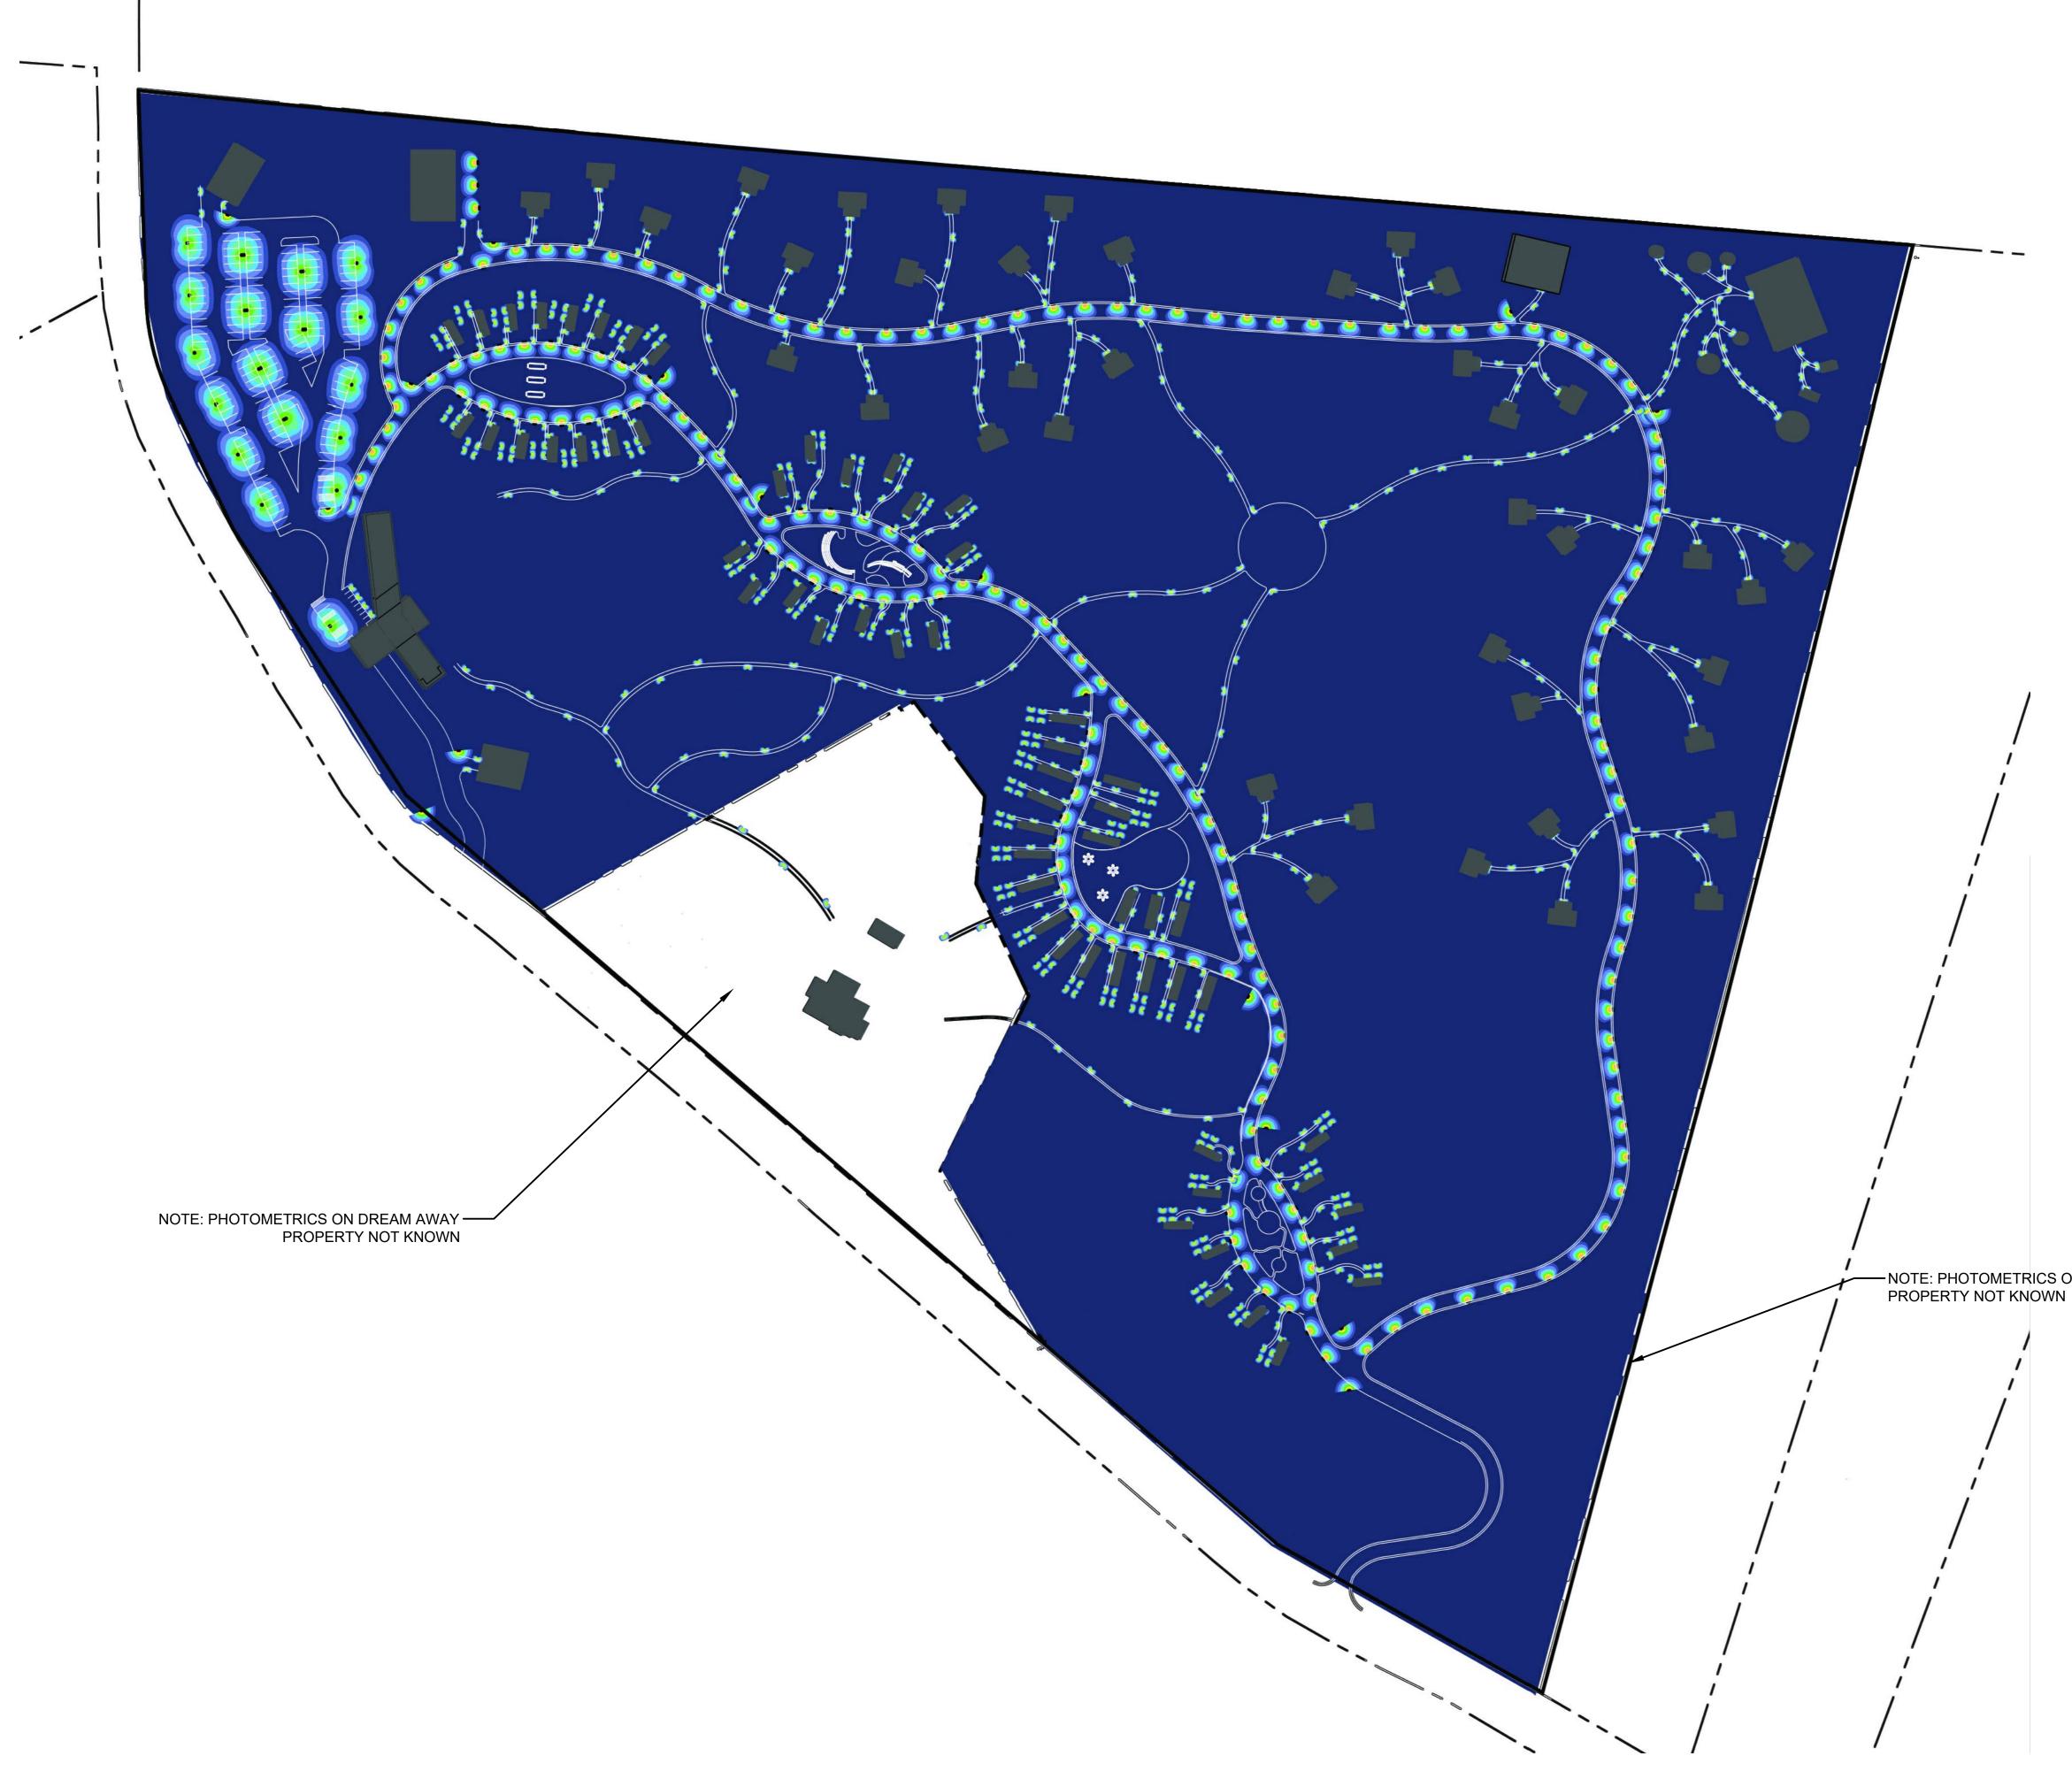


DIAGRAM LEGEND

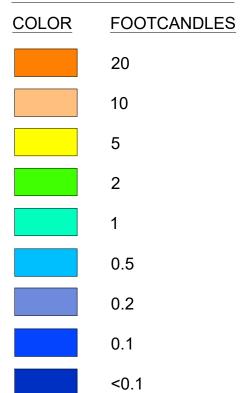

PHOTOMETRIC DIAGRAM NOTES:

- THE EXISTING LIGHTING ON ADJACENT PROPERTIES HAS NOT BEEN MEASURED. THIS DIAGRAM SHOWS ONLY THE LIGHT SPREAD OF NEW OR PROPOSED LANDSCAPE LIGHTS ON THE PROPERTY INCLUDED IN
- OR PROPOSED LANDSCAPE LIGHTS ON THE PROPERTY INCLODED IN THIS APPLICATION.
 LIGHT MOUNTED ON TENTS, CABINS, OR PERMANENT STRUCTURES WILL BE DOWN-LIGHTS CONTAINED UNDER EAVES FOR COMPLIANCE WITH DARK SKY REGULATIONS.
 NO DIRECTIONAL SPOT LIGHTS OR HIGH FLOOD LIGHTS ARE PROPOSED.

PHOTOMETRICS SCHEDULE

SYMBOL	DESCRIPTION	QTY
Э	BEGA 77 237 PATH LIGHT	1,337
0	BEGA ON-GROUND SURFACE WASH	351
\bigcirc	BEGA POLE-TOP LUMINAIRE 99 402; 12` MOUNT HEIGHT	24
\bigcirc	BEGA POLE-TOP TWIN LUMINAIRE 99 462; 12` MOUNT HEIGHT	13
•	BEGA WALL LUMINAIRE 44 418	33

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> 4 \geq 4 ROAD 01223 Ž 4 COUNTY MA Ш Ш Ш **BECKET**, I 342 **—** HTR

-NOTE: PHOTOMETRICS ON ABUTTING

Plot Date: <u>01/28/22</u>	Project #: <u>459.2</u>		
PRELIMINARY			

THIS SHEET CONTAINS LINES, SYMBOLS, ETC THAT ARE IN A COLOR OTHER THAN BLACK AND IS INTENDED TO BE VIEWED AND PRINTED IN COLOR VS B L A C K A N D W H I T E **SCALE:** 1"=100' 100' 200' 0'

LANDSCAPE LIGHTING PHOTOMETRIC DIAGRAM


Drawn By: CPS, JE Checked By: ST

ISSUE & REVISION DATES SITE PLAN APPLICATION 02/01/2022




LED wall luminaire - light output on one side

Application				Type:	
The LED wall mo	The LED wall mounted luminaire has light output on one side. Arranged individually or in groups, this is a great design element for a host of lighting		BEGA Product:		
	groups, this is a groups, this is a groups, this is a group of the second secon		or a host of lighting	Project:	
Materials	이 같은 것이 있는 것이 같은 것이 있다. 이 가지만 가지만 것이 있는 것이 같은 것이 있는 것이 있다. 이 가지만 것이 있는 것이 있 같은 것이 같은 것				
Luminaire housir copper free (≤0. Matte safety glas High temperatur	3% copper content	ie-cast and extruded) A360.0 aluminum a fasteners		Modified:	
NRTL listed to N Protection class Weight: 20.91bs		ndards, suitable for v	vet locations		
Electrical					
Operating voltag Minimum start te LED module wat System wattage Controllability Color rendering i Luminaire lumen Lifetime at Ta = 1	emperature tage index s 5°C	120-277V AC -30° C 23 W 0-10V dimmab Ra > 80 1228 lumens (3 >500,000 h (1.7	3000K) (0)		
Lifetime at Ta=5		182,000 h (L70	9		
3500K - Produ 3000K - Produ	uct number + K4 uct number + K35 uct number + K3 uct number + K3				
BEGA can supp	ly you with suitable	LED replacement m luminaires - see web			
Finish All BEGA standa minimum 3 mil th		e, textured polyeste	r powder coat with		
Available colors	Black (BLK)	C White (WHT)	© BAL:		
	Bronze (BRZ)	Silver (SLV)	D CUS:		

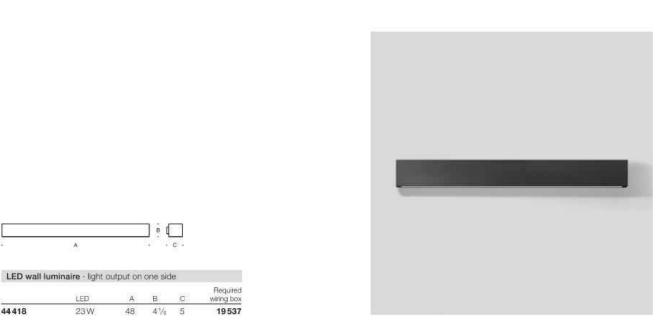

BEGA 1000 BEGA Way, Carpinteria, CA 93013 (805) 684-0533 info@bega-us.com Due to the dynamic nature of lighting products and the associated technologies, luminaire data on this sheet is subject to change at the discretion of 8EGA North America. For the most current technical data, please refer to bega-us, com 0 copyright 8EGA-2018

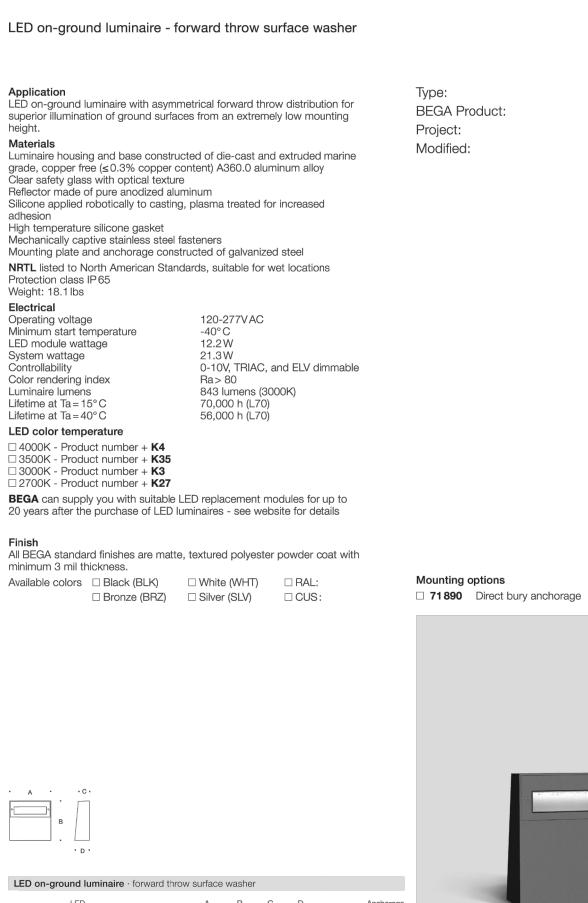

A B C D Anchorage 84081 12.2W 79 825 13¾ 14¾ 3½ 6⅛

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Due to the dynamic nature of lighting products and the associated technologies, luminaire data on this sheet is subject to change at the discretion of BEGA North America. For the most current technical data, please refer to bega-us.com




Photometric Filename: 44418.IES TEST: BE_44418 TEST LAB: BEGA DATE: LUMINAIRE: 44 418 LAMP:

BEGA

12/23/2016 23W LED

Characteristics	
IES Classification	Type VS
Longitudinal Classification	Very Short
Lumens Per Lamp	N.A. (absolute)
Total Lamp Lumens	N.A. (absolute)
Luminaire Lumens	1228
Downward Total Efficiency	N.A.
Total Luminaire Efficiency	N.A.
Luminaire Efficacy Rating (LER)	45
Total Luminaire Watts	27
Ballast Factor	1.00
Upward Waste Light Ratio	N.A.
Max. Cd.	442.7 (90H, 0V)
Max. Cd. (<90 Vert.)	442.7 (90H, 0V)
Max. Cd. (At 90 Deg. Vert.)	.2 (0.0%Lum)
Max. Cd. (80 to <90 Deg. Vert.)	45.9 (3.7%Lum)
Cutoff Classification (deprecated)	N.A. (absolute)

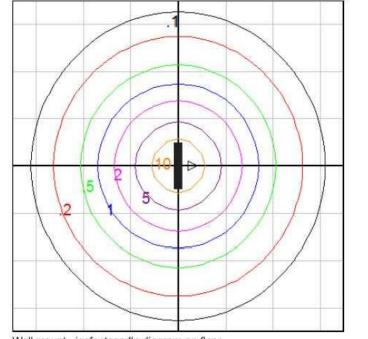

Wall mount - isofootcandle diagram on floor Mounting Height = 5 ft. Grid Spacing = 5 ft.

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BEGA



Photometric Filename: 84081.ies


TEST: TEST LAB: DATE: LUMINAIRE: LAMP:

Characteristics

BEGA 5/14/2018 84 081 12.2W LED


BE_84081


IES Classification	Type IV
Longitudinal Classification	Very Short
Lumens Per Lamp	N.A. (absolute)
Total Lamp Lumens	N.A. (absolute)
Luminaire Lumens 8	843
Downward Total Efficiency	N.A.
Total Luminaire Efficiency	N.A.
Luminaire Efficacy Rating (LER)	53
Total Luminaire Watts	16
Ballast Factor	1.00
Upward Waste Light Ratio (0.08
Max. Cd.	2376.3 (360H, 80V)
Max. Cd. (<90 Vert.)	2376.3 (360H, 80V)
Max. Cd. (At 90 Deg. Vert.)	403.6 (47.9%Lum)
Max. Cd. (80 to <90 Deg. Vert.) 2	2376.3 (281.9%Lum)
Cutoff Classification (deprecated)	N.A. (absolute)

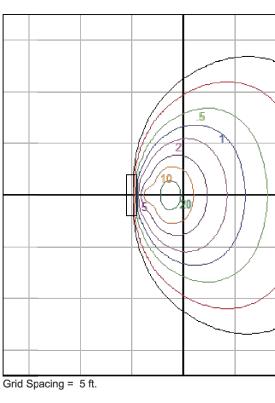


In the interest of product improvement, BEGA reserves the right to make technical changes without notice. BEGA 1000 Bega Way, Carpinteria, CA 93013 (805)684-0533 Fax (805)566-9474 www.bega-us.com © Copyright BEGA-US 2018



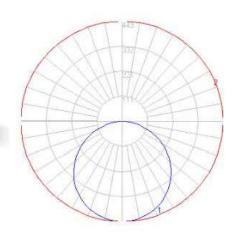

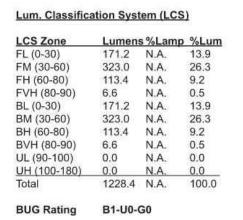

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8/21/2018

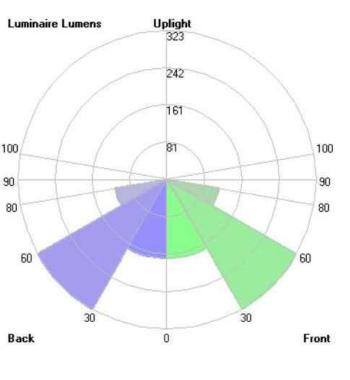LED garden and pathway bollard

Post construction: One piece extruded aluminum. All aluminum in the construction is marine grade and copper free. Lamp Enclosure: One piece die cast aluminum housing attached to post by two (2) stainless steel set screws. Matte safety glass lens. Fully gasketed using a one piece molded silicone gasket.

Electrical: 2.1W LED luminaire, 3.4 total system watts, -30°C start temperature. Integral 12V AC driver provided must be operated using remote magnetic transformer. Standard LED color temperature is 3000K with a >90 CRI. Note: LEDs supplied with luminaire. Due to the dynamic nature of LED technology, LED luminaire data on this sheet is subject

to change at the discretion of BEGA-US. For the most current technical data, please refer to www.bega-us.com. Anchor base: Anchor post provided made of galvanized steel. Bollards are secured to post using two (2) stainless steel set screws.

Finish: Available in four standard BEGA colors: Black (BLK); White (WHT); Bronze (BRZ); Silver (SLV). To specify, add appropriate suffix to catalog number. Custom colors supplied on special order.

Please note: BEGA's approach to product design is to Innovate, not follow. With a steadfast commitment to quality, each product is conceived to satisfy a general or specific lighting task as defined by its architectural or exterior surroundings. The Home and Garden Collection is designed specifically for use in Residential and Light Commercial applications. Please reference our standard BEGA portfolio when mounting provisions for the rigorous demands of high-use commercial and/or vandal prone settings are required. CSA certified to U.S. and Canadian standards, suitable for wet

locations. Protection class IP65 Weight: 6.3 lbs.


Luminaire Lumens: 136

Type: BEGA Product: Project: Voltage: Color: Options: Modified:


+A - +D -
 Lamp
 A
 B
 C
 D

 77237
 with direct bunal anchorage
 2.1 W LED
 3 ½
 27 ½
 4 ½


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LCS Zone	Lumens	%Lamp	%Lum
FL (0-30)	0.1	N.A.	0.0
FM (30-60)	17.4	N.A.	2.1
FH (60-80)	371.3	N.A.	44.1
FVH(80-90)	385.1	N.A.	45.7
BL (0-30)	< 0.05	N.A.	0.0
BM (30-60)	< 0.05	N.A.	0.0
BH (60-80)	< 0.05	N.A.	0.0
BVH(80-90)	< 0.05	N.A.	0.0
UL (90-100)	58.1	N.A.	6.9
UH (100-180)	10.8	N.A.	1.3
Total	842.8	N.A.	100.0
BUG Rating	B0-U3-G3		

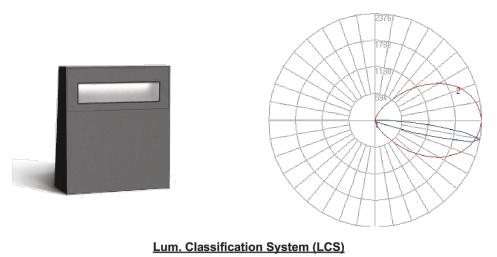

5/14/2018

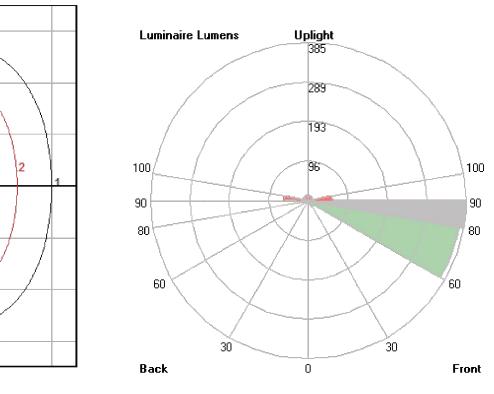

2/15/2017 BEGA 1000 Bega Way, Carpinteria, CA 93013 (805)684-0533 Fax (805)566-9474 www.bega-us.com © Copyright BEGA-US 2017
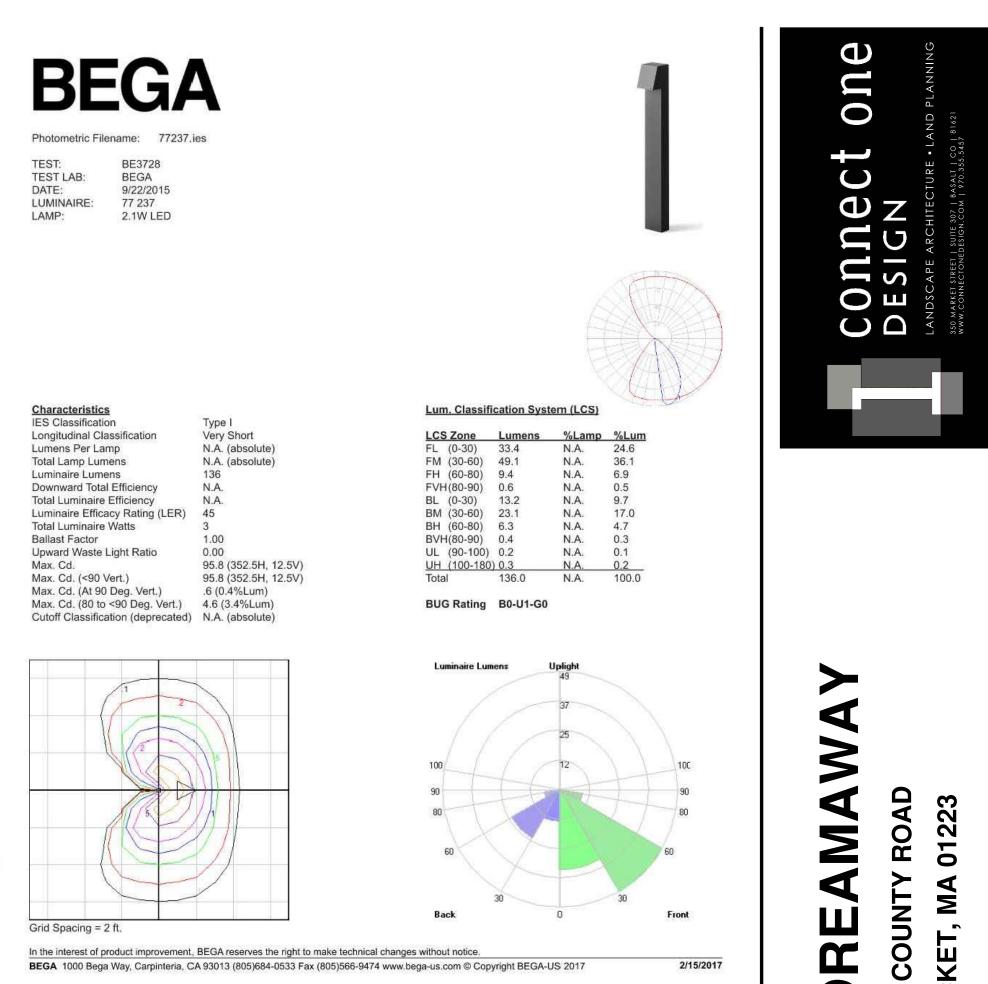
> Drawn By: CPS, JE Checked By: ST ISSUE & REVISION DATES SITE PLAN APPLICATION 02/01/2022

> Plot Date: 01/28/22 Project #: 459.2

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EXAMPLE LANDSCAPE **LIGHTING FIXTURES**



LED pole top I	uminaires	with	asymmetrical	flat be	am	liaht	distribution	

Type:

Project:

Voltage:

Options:

Modified:

Color:

BEGA Product:

Housing: Die-cast aluminum housing and slip fitter. Slip fits 3" O.D.

pole top, secures to pole with three stainless steel set screws. Die

castings are marine grade, copper free (≤ 0.3% copper content)

Enclosure: Faceplate is constructed of die-cast aluminum and

is secured to housing with mechanically captive stainless steel

aluminum. Fully shielded to comply with LEED zones 1 and higher.

Fully gasketed for weather tight operation using molded silicone

fasteners. Tempered clear class. Reflector of pure anodized

Electrical: 16W LED luminaire, 19 total system watts, -30°C

start temperature. Integral 120V through 277V electronic LED

available from factory for easy replacement. Standard LED color

Note: LEDs supplied with luminaire. Due to the dynamic nature

of LED technology, LED luminaire data on this sheet is subject

to change at the discretion of BEGA-US. For the most current

Finish: All BEGA standard finishes are polyester powder coat with

minimum 3 mil thickness. Available in four standard BEGA colors:

Black (BLK); White (WHT); Bronze (BRZ); Silver (SLV). To specify,

add appropriate suffix to catalog number. Custom colors supplied

CSA certified to U.S. and Canadian standards, suitable for wet

technical data, please refer to www.bega-us.com.

EPA (Effective projection area): 0.32 sq. ft.

temperature is 4000K with an 85 CRI. Available in 3000K (85 CRI);

driver, 0-10V, TRIAC and ELV dimmable. LED module(s) are

A360.0 aluminum alloy.

rubber "U-channel" gasket.

add suffix K3 to order.

on special order.

Weight: 8.6 lbs.

locations. Protection class IP65

Luminaire Lumens: 1855



Photometric Filename: 99402.IES TEST: BE_99402 TEST LAB: BEGA DATE: LUMINAIRE: 3/15/2017 99 402 16W LED LAMP:

Characteristics

IES Classification

Lumens Per Lamp

Total Lamp Lumens

Luminaire Lumens

Longitudinal Classification

Downward Total Efficiency

Luminaire Efficacy Rating (LER) 98

Max. Cd. (80 to <90 Deg. Vert.) 123.4 (6.7%Lum)

Cutoff Classification (deprecated) N.A. (absolute)

Total Luminaire Efficiency

Upward Waste Light Ratio

Max. Cd. (At 90 Deg. Vert.)

Total Luminaire Watts

Max. Cd. (<90 Vert.)


Ballast Factor

Max. Cd.

Total

100

Back

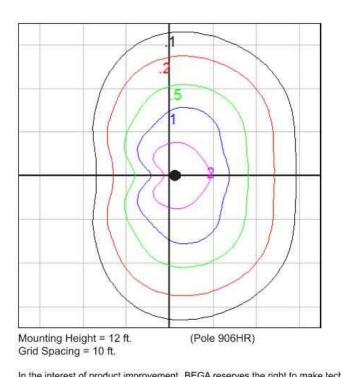

Type III

N.A. (absolute)

N.A. (absolute)

716.2 (300H, 55V)

716.2 (300H, 55V)

0 (0.0%Lum)

Short

1855

N.A.

N.A.


1.00


0.00


i Dram Single LED Poletop A B C Lamp 99402 16W LED 11% 3% 16 Recommended for use with 20' to 30' poles.

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Twin LED pole top luminaires with asymmetrical flat beam light distribution

Housing: Die-cast aluminum housing and slip fitter. Slip fits 3" O.D. pole top, secures to pole with three stainless steel set screws. Die castings are marine grade, copper free (≤ 0.3% copper content) A360.0 aluminum allov. Enclosure: Faceplate is constructed of die-cast aluminum and is secured to housing with mechanically captive stainless steel

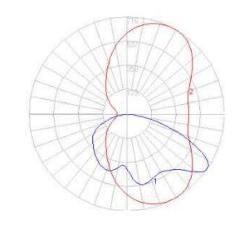fasteners. Tempered clear class. Reflector of pure anodized aluminum. Fully shielded to comply with LEED zones 1 and higher. Fully gasketed for weather tight operation using molded silicone rubber "U-channel" gasket. Electrical: 32W LED (16W per head) luminaire, 38 total system watts, -30°C start temperature. Integral 120V through 277V

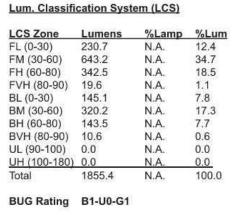electronic LED driver, 0-10V, TRIAC and ELV dimmable. LED module(s) are available from factory for easy replacement. Standard LED color temperature is 3000K with an 85 CRI. Available in 4000K (85 CRI); add suffix K4 to order. Note: LEDs supplied with luminaire. Due to the dynamic nature

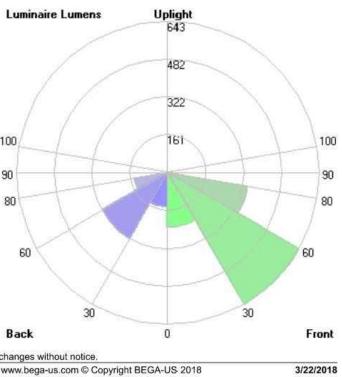of LED technology, LED luminaire data on this sheet is subject to change at the discretion of BEGA-US. For the most current technical data, please refer to www.bega-us.com. Finish: All BEGA standard finishes are polyester powder coat with

minimum 3 mil thickness, Available in four standard BEGA colors: Black (BLK); White (WHT); Bronze (BRZ); Silver (SLV). To specify, add appropriate suffix to catalog number. Custom colors supplied on special order.

CSA certified to U.S. and Canadian standards, suitable for wet locations. Protection class IP65

Weight: 15.9 lbs. EPA (Effective projection area): 0.54 sq. ft.

Luminaire Lumens: (2) 1855

Type: **BEGA Product:** Project: Voltage: Color: Options: Modified:



Mounting Height = 12 ft.

Grid Spacing = 15 ft.


(Pole 906HR)

ф — į \bigcirc c -

Twin LED Poletop A B C Lamp 99462 (2) 16.0W LED 11% 3% 28%

Recommended for use with 20' to 30' poles.

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Drawn By: CPS, JE Checked By: ST		
ISSUE & REVISION DATES		
SITE PLAN APPLICATION		02/01/2022
Plot Date: 01/28/22	Project #: 459.2	

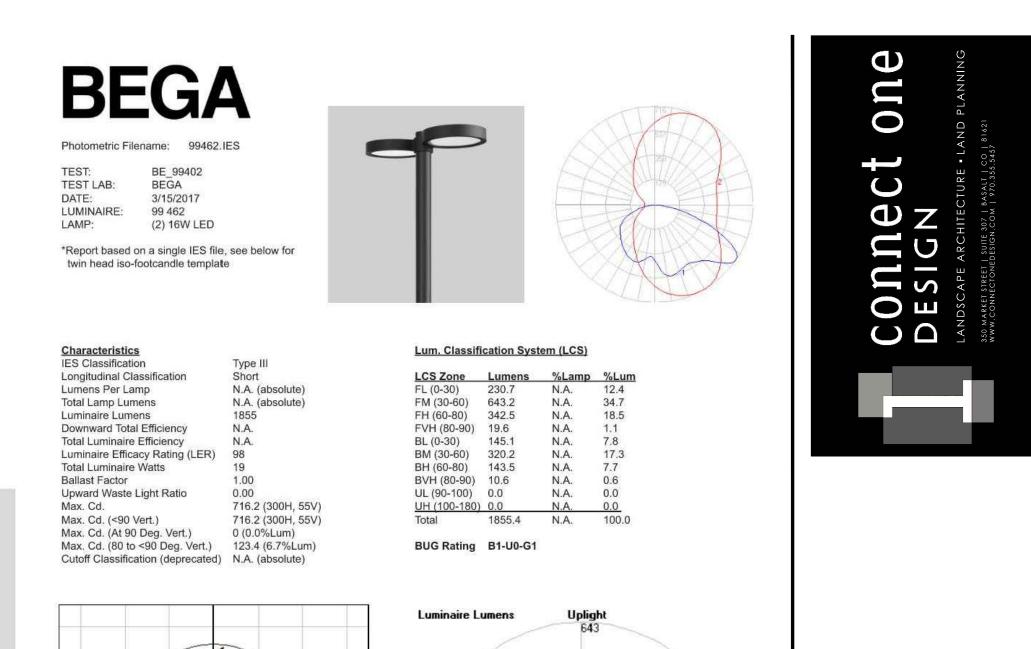EXAMPLE LANDSCAPE LIGHTING FIXTURES



